



Block Plan
scale 1:2000


- Notes:**
1. This drawing is to be read in conjunction with the other Architectural, Structural and Services drawings.
 2. Do not scale off this drawing.
 3. All dimensions are in millimetres
 4. Unless otherwise specified, cover to all reinforcement above DPC level to be 30mm
 5. Concrete grade to be C45/55, XS1, unless otherwise indicated.
 6. Steel marked T to be high yield, minimum strength 460 MPa.
 7. All laps to 40x bar diameter
 8. Outdoor platform slabs to be cast laid to falls away from room

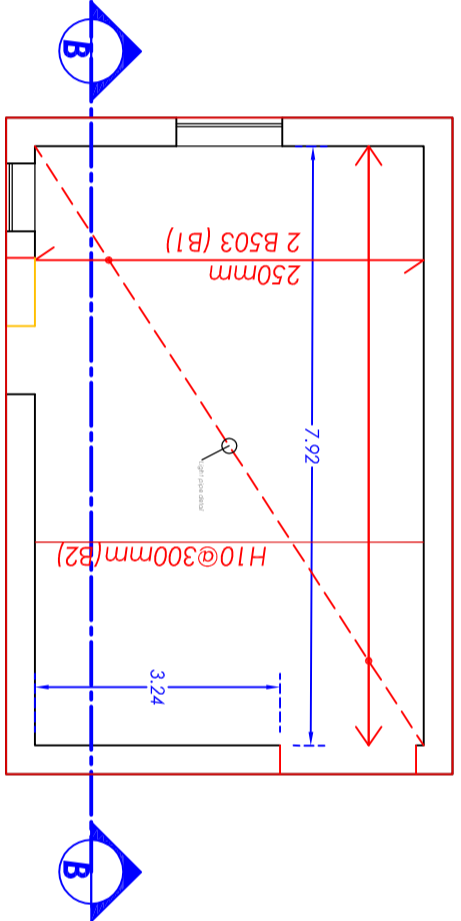


Slab over Room (B) Plan
scale 1:100

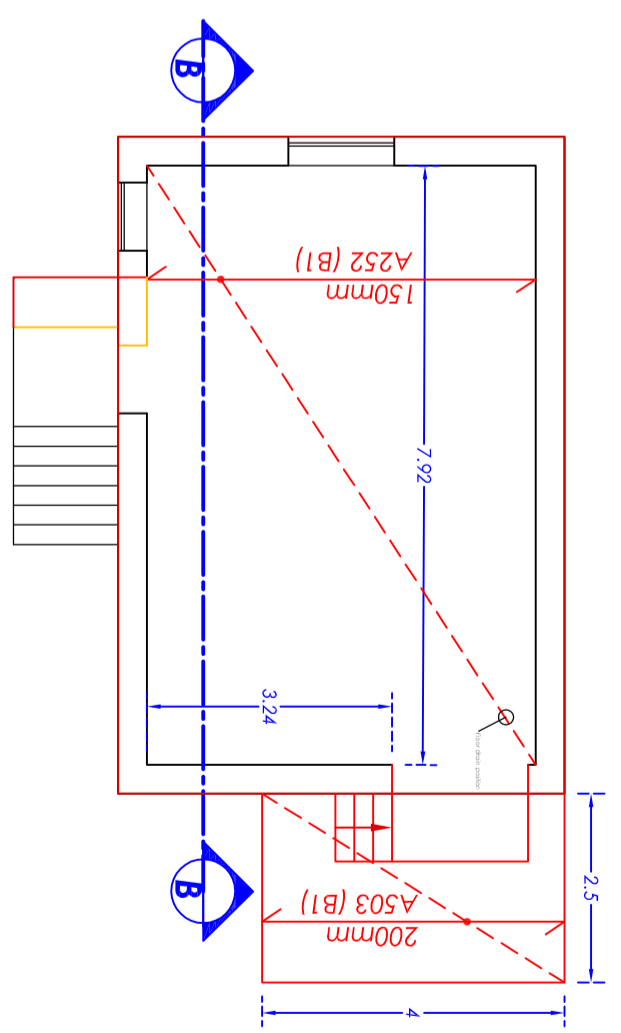


Ground floor Room (B) Plan
scale 1:100

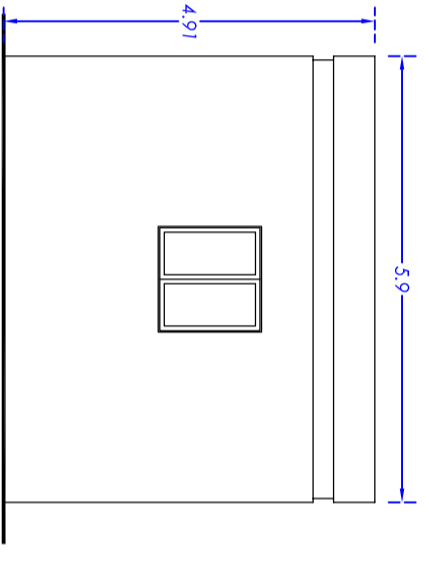


Side Elevation
scale 1:100

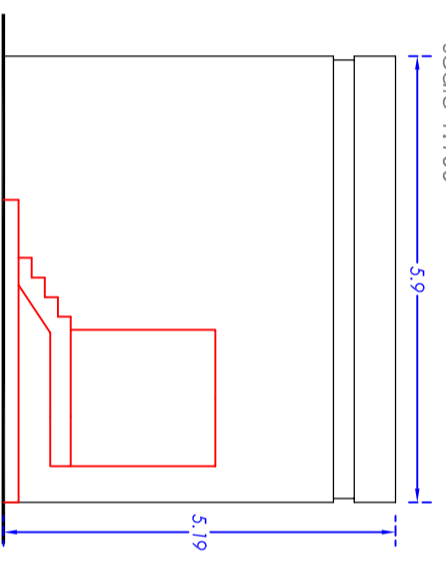


Side Elevation
scale 1:100

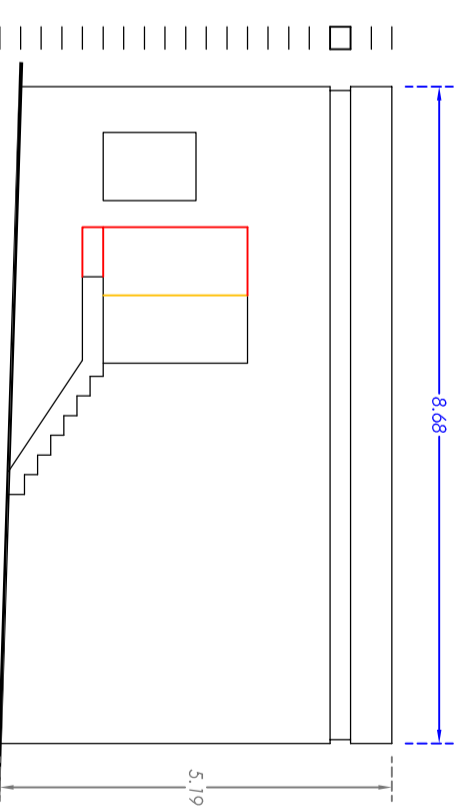

Front Elevation
scale 1:100

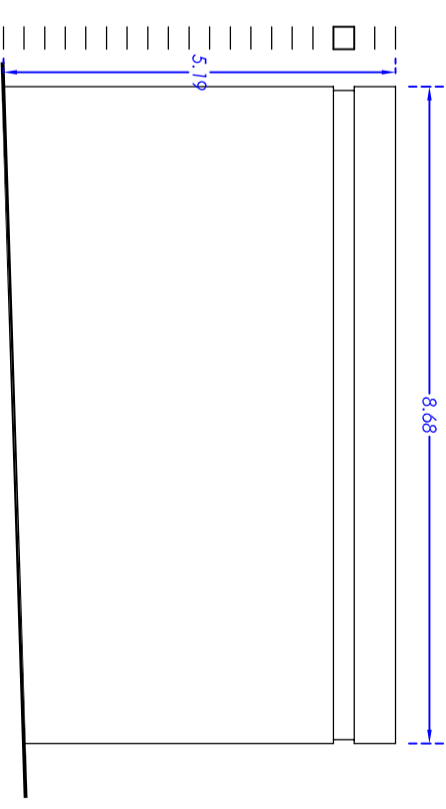


Back Elevation
scale 1:100

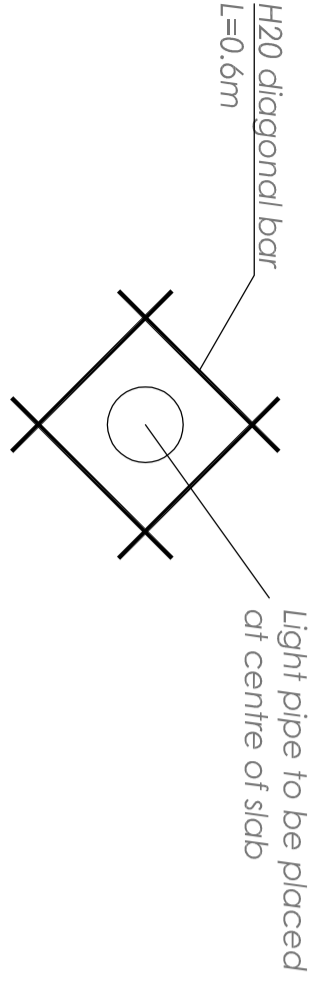

Light pipe detail
scale 1:20

Light pipe to be placed at centre of slab

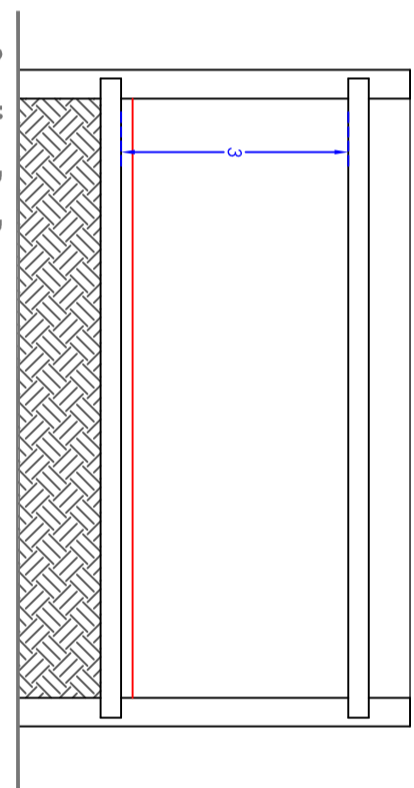

Section B - B
scale 1:100

Prof. Perit Ruben Paul Borg
B.E.&A.(Hons.)(Melit.), Spec.Struct.Eng.(Milan), Ph.D.(Sheffield)
Eur.Eng., C.Eng, MICE, C.Env., MIED, MICT, MCS, MASCE, A.&C.E

Address:
25, TRIQ LUIGI BILLION,
PEMBROKE PBK-1372
Tel:
+356 21375245
E-Mail
ruben.p.borg@gmail.com
Mob:
+356 79055680

Project:
Xrobb I-Ghagin Nature Park

Project Ref. No.:
07.2015
Date:
12-01-2020

Drawing Title:
Outbuildings - Plans, Section & Elevation

Drawn By: OB	Checked By: RPB	Scale: 1:100 on A2	Dwg. No.: D10
-----------------	--------------------	--------------------------	------------------